
Downtown Development District **Building Renovations**

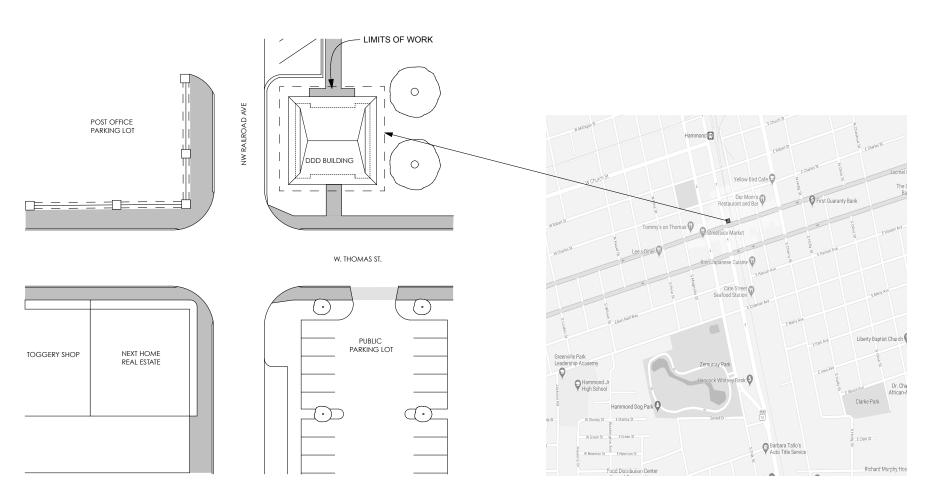



ACCESSIBILITY GENERAL NOTES:

- A. ACCESSIBLE ENTRANCES TO THE BLDG. SHALL BE IDENTIFIED BY THE INTERNATIONAL SYMBOL OF ACCESSIBILITY
- ACCESSIBLE AREAS & WITHIN 6' OF ADJACENT GROUND LEVEL, SHALL BE ACCESSIBLE.
- C. ACCESSIBLE RAMPS REQ. BY ANSI A117.1 SHALL NOT HAVE HANDRAILS BOTH SIDES, EVEN IF NOT SHOWN ON THE
- DRAWINGS.

 D. THE SURFACE OF RAMPS AND GROUND SURFACES SHALL
 BE ROUGHENED OR SHALL BE OF SLIP RESISTANT MATERIALS.
- F. AN ACCESSIBLE ROUTE OF TRAVEL 3ET, WIDE MIN. MUST BE E. AN ACCESSIBLE ROUTE OF IRAVEL ST. BLDG. AND BETWEEN THE BLDG. AND THE PUBLIC WAY.
 F. THRESHOLD MUST BE 1/2" IN HEIGHT OR LESS.
 G. ALL ACCESSIBLE PARKING SPACES SHALL HAVE A SLOPE
- H. ALL ACCESSIBLE PARKING SPACES SHALL BE OUTLINED ON ALL FOUR SIDES. HAVE A CONTRASTING COLOR AND THE INTERNATIONAL WHEELCHAIR SYMBOL ON THE GROUND
- INTERNATIONAL WHEELCHAIR SYMBOL ON THE GROUND WITHIN THE SPACE.

 1. ALL ACCESSIBLE PARKING SPACES SHALL HAVE A SIGN (MIN 5 FT. ABOVE FINISH GRADE IN FRONT OF THE SPACE.) WHICH INCLUDESTHE INTERNATIONAL SYMBOL OF ACCESSIBILITY.
- I. SIGNS DESIGNATING PERMANENT ROOMS AND SPACES
- SIGNED DESIGNATING PERMANENT ROUNS AND STACES
 SHALL MEET ACCESSIBILITY REQUIREMENTS.
 K. ALL ALARMS SHALL MEET ACCESSIBILITY REQUIREMENTS.
 L. ACCESSIBLE ROUTE SHALL BE WITHOUT STEPS OR CHANGES
 IN LEVEL GREATER THAN 1/2" WITHOUT AN APPROVED
- M ACCESSIBLE POLITES SHALL SERVE AS EXITS OR CONNECT

PROJECT INDEX:

ARCHITECTURAL

G-002 A-101 ADA DETAILS FLOOR/RCP PLAN FINISH PLAN

CIVIL

LANDSCAPE **MECHANICAL**

PLUMBING PLUMBING PLAN

ELECTRICAL

PROJECT DATA:

RENOVATION OF THE DOWNTOWN DEVELOPMEN DISTRICT BUILDING WILL PROVIDE TWO PUBLIC RESTROOMS ALONG WITH ADDITIONAL WORK STATIONS AND STORAGE AREAS.

CITY OF HAMMOND DOWNTOWN DEVELOPMENT DISTRICT 2 W. THOMAS ST. HAMMOND, LA 70401

> PISTORIUSASSOCIATES, LLC ATTN: TOM PISTORIUS, AIA P.O.BOX 673 HAMMOND, LA 70401 PHONE - 985-542-4287

BUILDING: 798 SF

CODE: 2015 IBC (INTERNATIONAL BUILDING CODE) 2015 NFPA LIFE SAFETY CODE

pistorius associates. Il c ARCHITECTS

985.542.4287

PROJECT GENERAL NOTES:

- A. DO NOT SCALE DRAWINGS
- B. TYPICAL DETAILS MAY NOT NECESSARILY BE CUT ON
- B. I YPICAL DEIAILS MAY NO! NECESSARILY BE CUI ON PLANS, BUT APPLY NULSES NOTED OTHERWISE.

 C. ALL WORK AND MATERIAL SHALL BE REGARDED AS NEW UNLESS SPECIFICALLY INDICATED AS "EXISTING" OR "(E)" ON THE DRAWINGS.

 D. CONTRACTOR SHALL COORDINATE ALL TRADES AND METHODS OF CONSTRUCTION AS REQUIRED FOR
- COMPLETION OF THE PROJECT WITH THE INTENT OF THESE
- DOCUMENTS.

 E. ALL MATERIALS AND UNFINISHED SURFACES EXPOSED TO VIEW SHALL BE PAINTED UNLESS FACTORY PRE-FINISHED, NOTED OTHERWISE OR DIRECTED BY THE ARCHITECT. F. NO UTILITIES, PLUMBING, PIPING, CONDUIT, ETC. SHALL BE EXPOSED WITHOUT THE WRITTEN APPROVAL OF THE
- ARCHITECT.
- G. SHOULD DIMENSIONS BE MISSING OR CONFLICTING MOTIFY ARCHITECT PRIOR TO PROCEEDING WITH RELATED WORK.
 H. CONTRACTOR SHALL VERIFY LOCATIONS OF UTILITIES.
- PRIOR TO EXCAVATING, TRENCHING, ETC. AND SHALL REPAIR OR REPLACE UTILITIES DAMAGED AS A RESULT OF
- CONSTRUCTION:

 I. CONTRACTION: SHALL BE RESPONSIBLE FOR ALL

 TEMPORARY SHORING AND BRACING REQUIRED DURING
 CONSTRUCTION.

 J. SECURITY AND SAFETY ARE THE CONTRACTOR'S
- RESPONSIBILITY. LIMITS OF CONSTRUCTION SHALL BE COMPLETELY FENCED AND SECURED DURING CONSTRUCTION
- CONSTRUCTION.
 K, NO ASBESTIOS SHALL BE USED OR INCORPORATED INTO THE PROJECT IN ANY FORM.
 L. SEPARAIE DISSIMILAR METALS AS THEY OCCUR AND/OR PER MANUFACTURER'S RECOMMENDATIONS.
 M. APPLY SEALANT AT INTERSECTIONS OF ALL DISSIMILAR
- N NOT LISED
- N. NOT USED

 O. BRACE INTERIOR NON-BEARING WALLS TO STRUCTURE PER
 ARCHITECTURAL DRAWINGS.
 P. PROVIDE INSULATION AT ALL INTERIOR WALLS AND
 CEILING/ROOF ASSEMBLES.
- Q. ALL EXTERIOR OPENINGS, WINDOWS AND DOORS SHALL BE FLASHED & COUNTER-FLASHED.
- BE FLASHED & COUNTER-FLASHED.

 R. WATER RESISTANT GRY, BD. TO BE USED AT TUBS AND SHOWERS, MIN. 72" HIGH. WALL FINISH TO COMPLY WITH R.307.2.

 S. UNLESS NOTED OTHERWISE, ELECTRICAL CONDUITS, PLUMBING LINES, AND MECHANICAL PIPING SHALL BE
- CONCEALED AND FRAMING SHALL BE OF ADEQUATE DIMENSION TO ACCOMPLISH THIS RESULT WITHOUT DIMENSION IO ACCOMPLISH THIS RESULT WITHOUT UNNECESSARY CHANGES IN THE WALL PLANE.

 I. INTERIOR FINISH SURFACES SHALL NOT BE INSTALLED PRIOR TO HAVING THE BUILDING WEATHER TIGHT.

 U. DRYER VENT/CLOTHES DRYER ARE TO BE PROVIDED WITH
- AN EXHAUST DUCT NOT TO EXCEED 25 FEET IN LENGTH THE MAXIMUM ALLOWED LENGTH IS REDUCED BY 2.5 F FOR EACH 45 DEGREE BEND AND 5 FT FOR EACH 90
- FOR EACH 45 DEGREE BEND AND 5 FT FOR EACH YO DEGREE BEND.

 V. DOORS USED FOR BEDROOM EGRESS SHALL NOT BE KEYED ON THE INTERIOR SIDE.

 W. PROVIDE 2X6 BLOCKING FOR ALL WALL MOUNTED
- HARDWARE AND ACCESSORIES.
- X. NOTES AND LEGENDS ARE TYPICAL FOR ALL FLOOR PLAN SHEETS, AND MAY NOT APPLY TO EACH FOR ALL FLOOR
 Y. REFERENCE STRUCTURAL FOR ITEMS NOT SHOWN.
 COORDINATE AS REQUIRED INCLUDING NECESSARY
- FRAMING, BLOCKING, ETC.

 Z. FIELD VERIFY ALL DIMENSIONS PRIOR TO FABRICATION OF ANY CABINETRY, FRAMES, STRUCTURAL ITEMS ETC.

Distric

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project number pa_2102


Design Development

M. Miller

GENERAL NOTES

VICINITY MAP

SITE PLAN

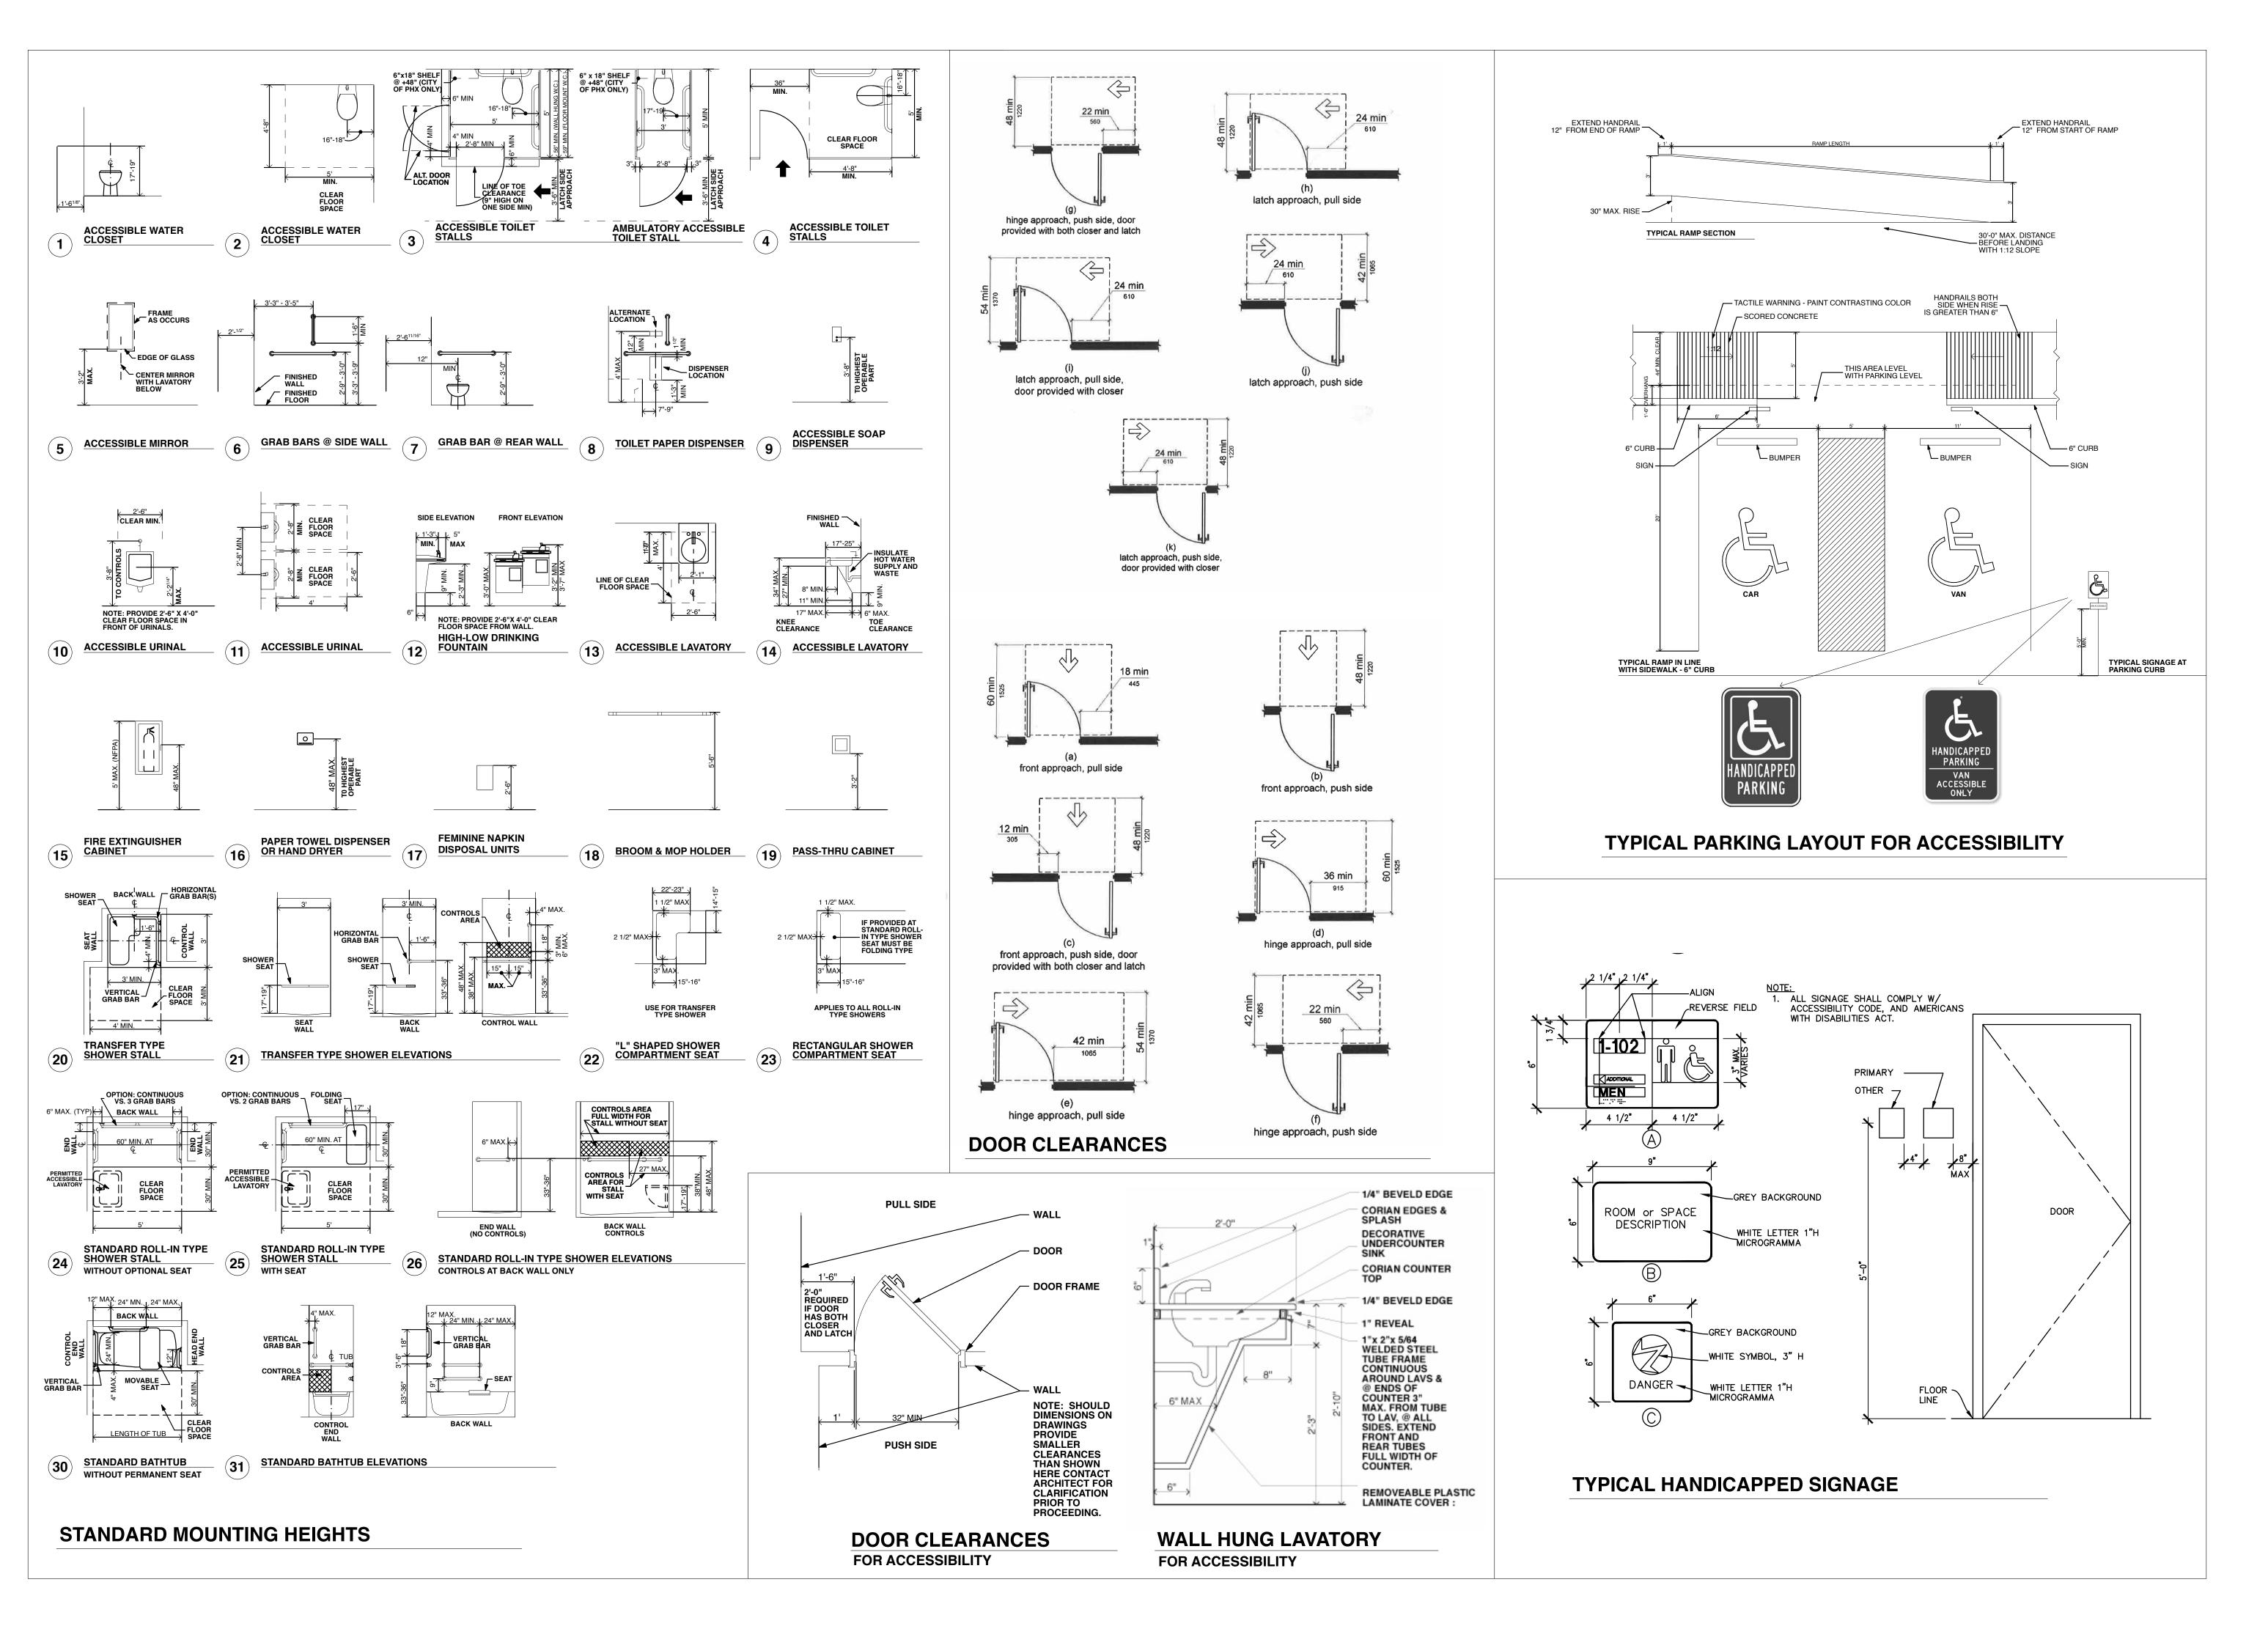



pistorius associates, llc ARCHITECTS studio 109 1/2 west thomas street hammond, la 70401

post office box 673

985.542.4287

hammond, la 70404

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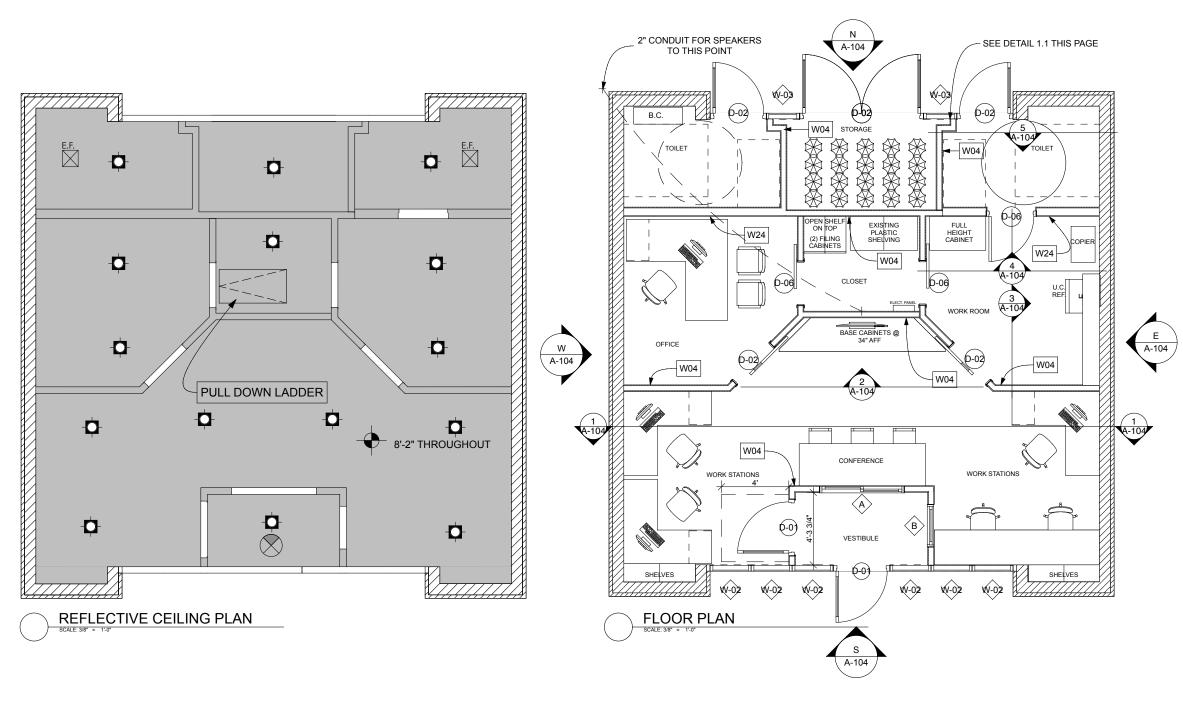
project number pa_2102 date of issue 04.05.2021

drawn by

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Construction Documents


drawing title
ADA DETAILS



MULLION GLASS EXPANDABLE FOAM, AS MANUFACTERED BY "WILL-SEAL", CONT., ATTACH WITH ADHESIVE TO STUD ONLY. CUSTOM BREAK METAL CAP, PRE-PAINT BLACK. DO NOT FASTEN


OFFSET WALL @ MULLION

1.1

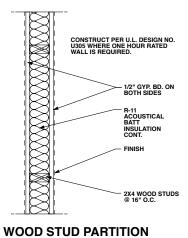

W

04

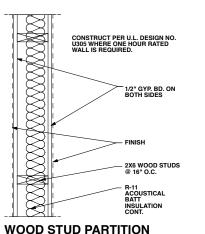

WOOD STUD PARTITION 24 AT 16" O.C.

REFLECTED CEILING PLAN LEGEND:

RECESSED CAN LIGHT FIXTURE



5/8" GYP, BOARD



EMERGENCY EXIT SIGN AND BUILT-IN EMERGENCY LIGHT





FLOOR PLAN GENERAL **NOTES:**

- A. KEYNOTES AND LEGENDS ARE TYPICAL FOR ALL FLOOR PLAN SHEETS, AND MAY NOT APPLY TO EACH SHEET.

 B. INITERIOR DIMENSIONS ARE TO FACE OF STUD AND CENTERINE OF COLUMNS UNLESS NOTED OTHERWISE.

 C. EXTERIOR DIMENSIONS ARE TO FACE OF STUD AND
- CENTERLINE OF COLUMNS.

- CENTERLINE OF COLUMNS.

 D. SEE ENLARGED FLOOR PLANS AND DETAILS FOR SPECIFIC LOCATIONS OF PLUMBING FIXTURES.

 E. HELD VERIFY ALL DIMENSIONS PRIOR TO FABRICATION OF ANY CABINETRY, FRAMES, STRUCTURAL ITEMS ETC.

 F. PROVIDE PAINTED ACCESS PANELS IN WALLS AND CEILINGS AT CONCEALED ITEMS, SUCH AS VALVES, SHOCK ABSORBERS, CONTROLS, SWITCHES, ETC., AND ANY OTHER ABSORBERS, CONIROLS, SWIICHES, EIC., AND ANY OHRE-ITEMS WHICH MAY REQUIRE ACCESS NOT OT DHERWISE PROVIDED. ACCESS PANEL LOCATIONS MAY NOT ALWAYS BE SHOWN ON THE PLANS. IT IS THE SUBCONTRACTORS RESPONSIBILITY TO DETERMINE LOCATIONS ACCESS PANEL LOCATIONS, REVIEW REFLECTED CEILING PLAN TO DETERMINE LOCATION OF GYPSUM BOARD CEILINGS WHERE ACCESS PANELS TYPICALLY REQUIRED.
- WHERE ACCESS PANELS TYPICALLY REQUIRED.

 G. COORDINATE WALLS WITH COLUMNS AND OTHER ENCASED ITEMS. COLUMNS ARE TO BE CONTAINED WITHIN WALLS. THE FRAMING CONTRACTOR SHALL INCREASE STUD SIZE TO ACCOMMODATE STEEL COLUMNS, DRAIN LEADERS, SOIL PIPES, ELECTRICAL PANELS FTC., CONTINUOUS ALONG THE FULL LENGTH OF THE WALL AS
- CONTINUOUS ALONG THE FULL LENGTH OF THE WALL AS REQUIRED, UNLESS NOTED OTHERWISE.

 H. ALL GUARDRAILS AND HANDRAILS SHALL BE FABRICATED AND INSTALLED IN ACCORDANCE WITH ALL REQUIREMENTS OF THE 2006 (J.B.C., AMERICANS WITH DISABILITIES ACT GUIDELINES, THE MOST STRINGENT SHALL DEPOLITY AND ACCORDANCE WITH ALL STRINGENT SHALL DEPOLITY AND ACCORDANCE WITH ALL STRINGENT SHALL. PREVAIL. ALL GUARDRAILS MAY NOT BE SHOWN ON PLANS. CONTRACTOR SHALL REVIEW ALL POSSIBLE
- FEATURE CONTRACTOR STREET REVIEW ALL POSSIBLE REQUIREMENTS IN THE FIELD. VERIFY AND COORDINATE ALL REQUIREMENTS FOR OWNER FURNISHED ITEMS, PRIOR TO PERFORMANCE OF ANY WORK THAT IS TO ACCOMMODATE AND INTERFACE WITH SUCH ITEMS.

 J. PROVIDE MINIMUM CLEARANCES AT ALL DOORS PER
- DETAILS.
- K. NOT USED. L. SEAL ALL PENETRATIONS IN FIRE RATED FLOORS AND WALLS
- IF REQUIRED.

 M EXTEND WALL INSULATION FROM FLOOR LINE TO MEET M EXTEND WALL INSULATION FROM FLOOR LINE TO MEET ROOF INSULATION, EXTERIOR WALL INSULATION, SHALL BE COMPLETELY COVERED BY 5/8" TYPE 'X' GWB TO 1'-0" ABOVE CEILING UNLESS NOTED OTHERWISE, CAREFULLY CUT ARCOUND ALL PENETRATIONS, ALL SECTIONS OF WALL INSULATION CUT OR REMOVED FOR CONDUIT RUNS, ETC., SHALL HAVE THE INSULATION REPLACED OR BE PACKED WITH BATT INSULATION. DICAPACCESSIBLE GRAB BARS AT TOURS PROVINCE MALL PROVINCE SENIOR CRAB
- AT TOILETS, PROVIDE IN-WALL BACKING BEHIND GRAB BARS PER MANUFACTURER RECOMMENDATIONS PROVIDE 18 GAUGE METAL STUDS BEHING FOLDING SEATS.

FLOOR PLAN LEGEND:

NEW 2X4 WOOD STUD @ 16" O.C. WALL WITH 5/8' GYPSUMBOARD FACH SIDE, USE 2X6 WOOD STUDS BEHIND ALL TOILET

EXISTING INTERIOR CMU BLOCK WALLS

EXISTING EXTERIOR BRICK WALLS



NEW BABY CHANGING TABLE



NEW WALL HUNG ADA SINK - SEE DETAILS ON G-002



NEW ADA TOILET WITH GRAB BARS - SEE DETAILS ON G-002



DOOR LABEL - SEE SCHEDULE ON A-XXX



WINDOW LABEL - SEE SCHEDULE ON A-XXX





ELEVATION MARKER



FLOOR PLAN NOTES



WALL ASSEMBLY DETAIL



pistorius associates. Il c ARCHITECTS

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Distric evelopment uilding Renovations nas Street Iouisiana Ŏ owntown

70401

Building 2 West Thom hammond, I


project numbe pa_2102


Design Development

drawn by M. Miller

THIS DRAWING IS AN INSTRUMENT OF SERVICE &

FLOOR/RCP PLANS

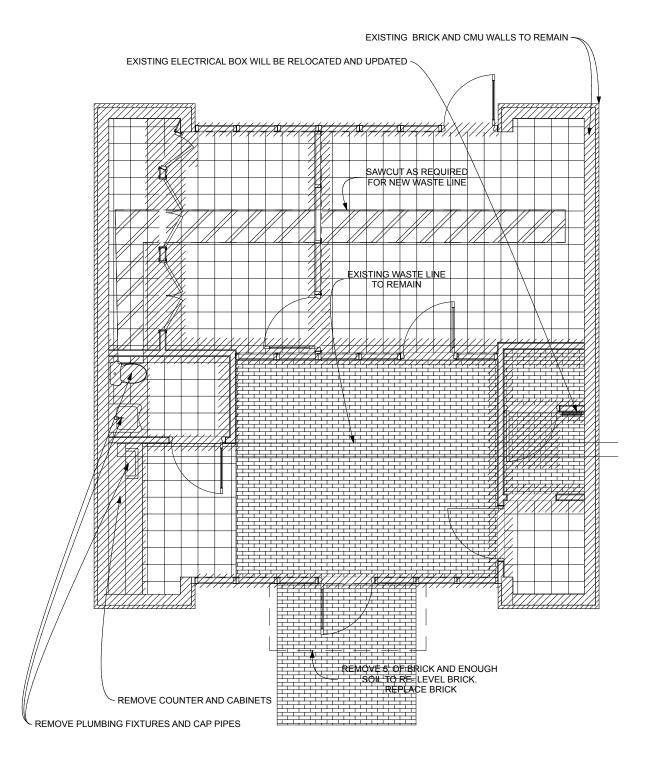

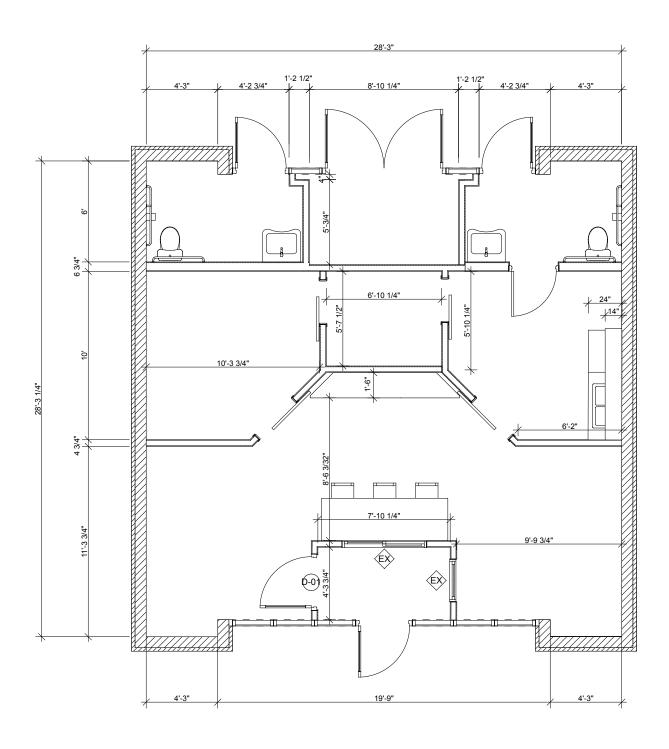



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Downtown Development District Building Renovations 2 West Thomas Street hammond, Iouisiana 70401

project number

project phase
Design Development

drawn by M. Miller

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DIMENSION PLAN

SCALE: 3/8" = 1'-0"

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-{			
		11 11 '	

COLOR AND	MATERIAL	SCHEDULE

COLOR A: COLOR B:

PLASTIC LAMINATE COUNTER TOP

COLOR C: __

PLASTIC LAMINATE BASE CABINETS

FLOOR FINISH PLAN



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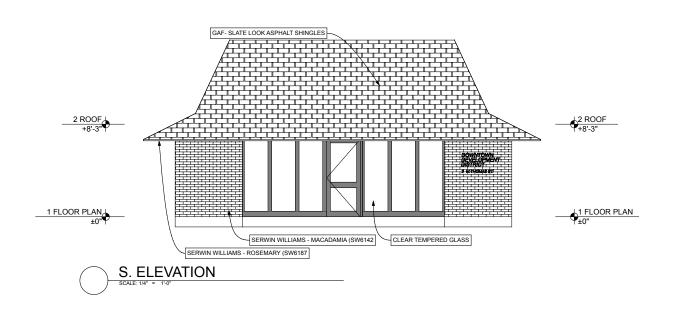
985.542.4287


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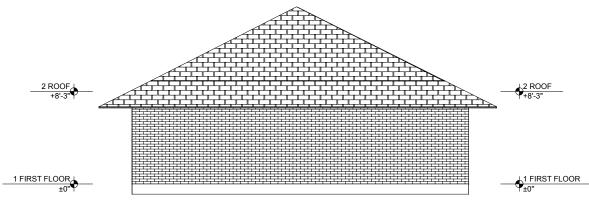
project number pa_2102

Design Development


drawn by M. Miller






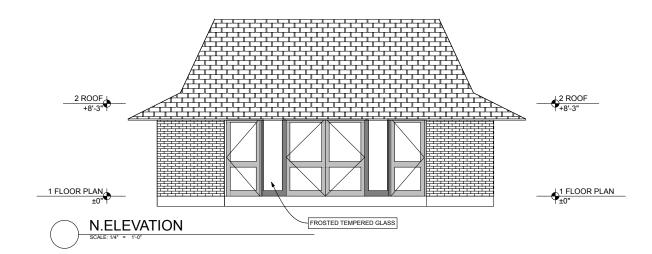





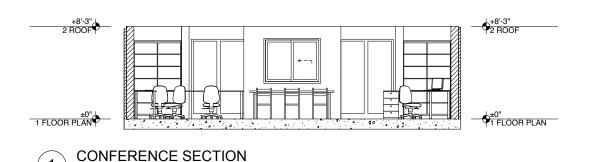

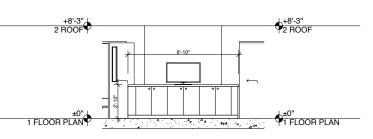



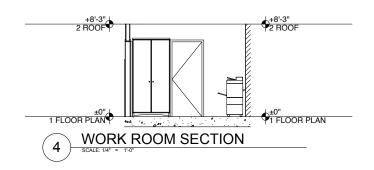


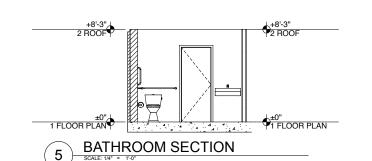

WORK ROOM SECTION

+8'-3" 2 ROOF

±0" 1 FLOOR PLAN

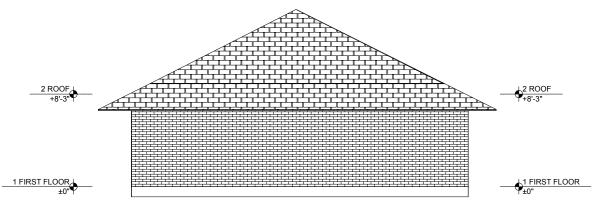

W. ELEVATION

SCALE: 1/4" = 1'-0"



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+8'-3" 2 ROOF

±0" 1 FLOOR PLAN

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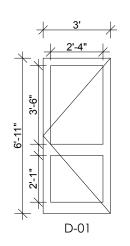
project number pa_2102 date of issue

project phase
Design Development

drawn by M. Miller


drawing title ELEVATIONS/SECTIONS

drawing no. A - 104




(MAIN ENTRANCE)

NEW KAWNEER 350 MEDIUM STILE ALUMINUM STOREFRONT ENTRANCE WITH CLEAR TEMPERED GLASS.

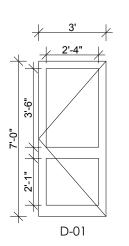


(VESTIBULE ENTRANCE)

NEW KAWNEER 350 MEDIUM STILE ALUMINUM STOREFRONT ENTRANCE WITH CLEAR TEMPERED GLASS.

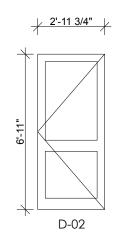


(EXTERIOR BATHROOM)

NEW KAWNEER 350 MEDIUM STILE ALUMINUM STOREFRONT ENTRANCE WITH FROSTED TEMPERED GLASS. PRIVACY LOCK FOR BOTH TOILET ROOMS

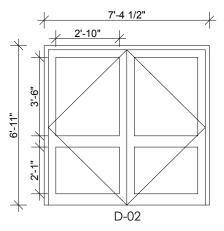


(STORAGE)

NEW KAWNEER 350 MEDIUM STILE ALUMINUM DOUBLE STOREFRONT ENTRANCE WITH FROSTED TEMPERED GLASS.

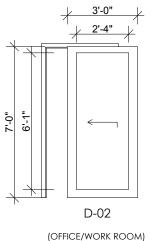


NEW SOLID WOOD VENEER SLIDING DOOR WITH CLEAR TEMPERED GLASS.

CLIHOME MATTE BLACK INTERIOR/EXTERIOR BARN DOOR KIT FROM LOWES

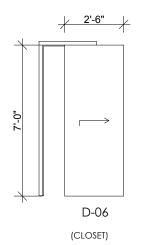

NEW SOLID WOOD VENEER SLIDING DOOR.

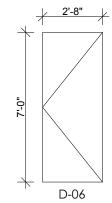


(INTERIOR BATHROOM ENTRANCE)

NEW SOLID WOOD VENEER DOOR KEYED DEAD BOLT BOTH SIDES WITH


DOOR SCHEDULE


DUPONT" FLASHING TAPE INSTALLATION GUIDELINES

Refer to the general instructions on back cover prior to installation

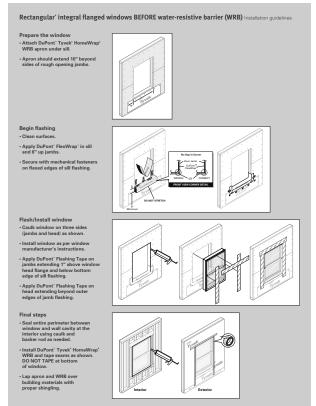




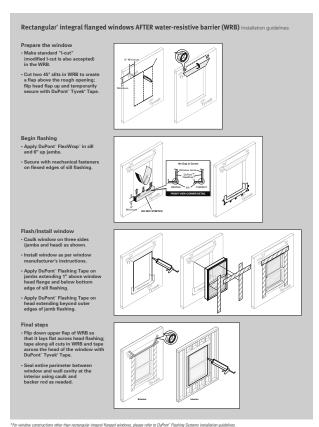

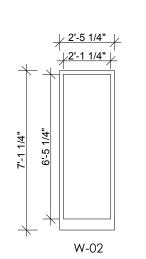


NEW KAWNEER TRIFAB 451 2" X 4 1/2" CENTER PLANE GLAZING WITH CLEAR TEMPERED GLASS



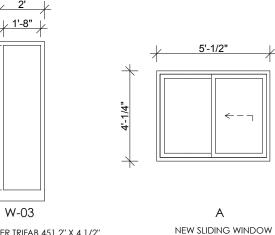

NEW KAWNEER TRIFAB 451 2" X 4 1/2" CENTER PLANE GLAZING WITH WHITE FROSTED TEMPERED GLASS

6'-5 1/4"

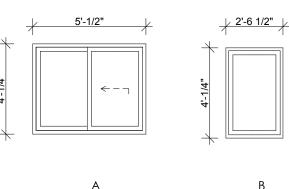

NEW FIXED WINDOW

DOOR/WINDOW SCHEDULES A-105

WINDOW SCHEDULE



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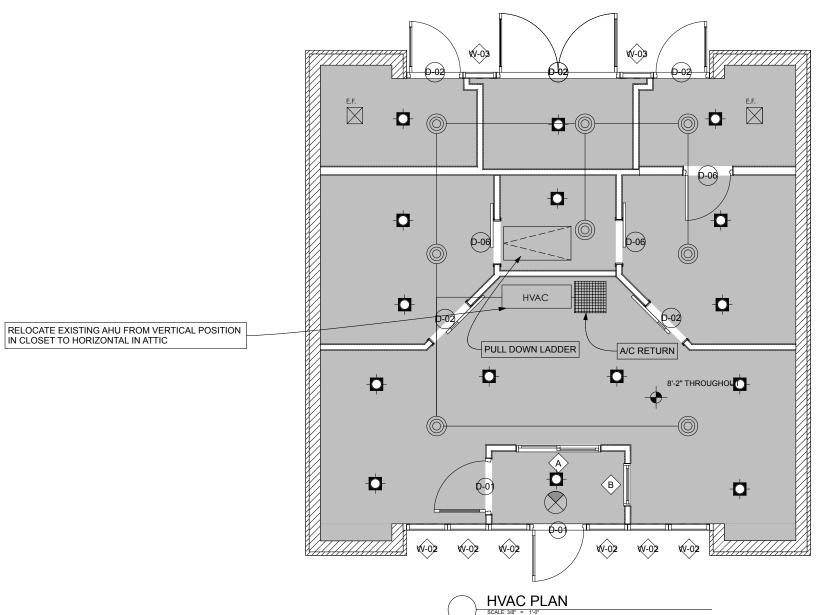
website pistoriusarchitects.com

Downtown Development District Building Renovations 2 West Thomas Street hammond, Iouisiana 70401

project number pa_2102

Design Development

M. Miller



MECHANICAL NOTES

- A. HVAC CONTRACTOR IS RESPONSIBLE FOR ALL DESIGN, SIZING, AND FUNCTIONING OF THE UNITS AND DUCTS. CONTRACTOR MUST VISIT THE SITE AND VERIFY ALL EXISTING CONDITIONS PRIOR TO DESIGNING A COMPLETE DUCT AND DIFFUSER RELOCATION.

 B. ALL HVAC WORK, INCLUDING BUT NOT LUMITED TO DUCTWORK, AIR HANDLERS, PIPING, SUPPLY VENTS, RETURN VENTS, CONDENSATE LINES, ETC. SHALL BE RELOCATED AND SIZED ACCORDINGLY IF NECESSAY PER THE REVISED CELLING PLAN LAYOUT OF ROOMS AND NEW LIGHT FIXTURES. C. ALL HVAC SYSTEMS AND UTILITIES SHALL BE INSTALLED IN ACCORDANCE WITH 101 LIFE SAFETY CODE.
- C. ALL HAVE STEWN SHIP DITTLES SHAELD
 CODE.

 D. ALL MECHANICAL INSTALLATIONS MUST MEET
 COMMERCIAL STANDARDS INCLUDING HEATING,
 COOLING, WATER HEATING, DUCTWORK, ETC.

 E. ALL MECHANICAL EQUIPMENT INCLUDING UNITS
 ABOVE CEILING MUST HAVE CLEARANCE TO
 ACCESS FOR SERVICING. COORDINATE LOCATION
 OF UNITS IN ORDER TO PROVIDE THIS.
 F. VERRY THAT EXISTING UNITS HAVE SMOKE
 DETECTORS INSTALLED OVER 2,000 CFM AND ARE
 CONNECTED TO THE SMOKE ALARM SYSTEM.

 G. CONTRACTOR SHALL RUN A COMPLETE TEST
 AND BALANCE OF THE SYSTEM AFTER INSTALLATION
 AND SHALL MAKE PROVISIONS TO ADJUST THE
 MECHANICIAL DESIGN IF IT DOES NOT MEET
 THE CORRECT LEVEL OF PERFORMANCE.



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Downtown Development District Building Renovations 2 West Thomas Street hammond, Iouisiana 70401

project number

Design Development

drawn by M. Miller

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drawing title
HVAC PLAN
drawing no.
H - 101

0-02 -HW/ 0-06 0-06 0-06 CONNECT TO EXISTING WASTE LINE. VERIFY INVERT HEIGHT AND NOTIFY ARCHITECT BEFORE SAW CUTTING SS CONNECT TO EXISTING WATER LINES $\langle A \rangle$ (B) (0-0) (0-0) W-02 W-02 W-02 W-02 W-02 W-02

PLUMBING PLAN
SCALE: 3/8" = 1'-0"

PLUMBING NOTES

- A. CONTRACTOR IS RESPONSIBLE FOR ALL DESIGN, SIZING, ONE INE DIAGRAMS, ETC. CONTRACTOR SHALL VISIT THE SITE PRIOR TO ANY INSTALLATION OR PRIOR TO SUBMITTING A PRICE TO OWNER.

 B. INSTALL COLD AND/OR HOT WATER LINES TO NEW FIXTURES COMPLETE WITH VALVES AND SHOCK ABSORBERS. PROVIDE ACCESS TO VALVES AS REQUIRED.

 C. ALL PLUMBING STANDARDS SUCH AS INSULATION OF PIPING SHALL BE EQUAL OR BETTER THAN WHAT IS EXISTING.



pistoriusassociates,llc ARCHITECTS

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website pistoriusarchitects.com

Downtown Development District Building Renovations 2 West Thomas Street hammond, louisiana 70401

project number pa_2102

Design Development
revision date

drawn by M. Miller

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PLUMBING PLAN drawing no.



Downtown Development District - Upgrades to the DDD Building

tom a. pistorius, architec 1091 west thomas stree 985.542.4287 • telephone

1000					
Demo	Removal of existing interior storefront walls, cabinets, plumbing fixtures, ceiling tiles and any wall material that needs replacing.		\$3,500.00		
Sitework	Potential Sewer Clean out or Replace, Redo Drainage around, Dig around foundation		\$3,000.00		
Allowances	Asbestos Abatement, Removal of Existing Roof		\$10,000.00		
New Roofing			\$9,000.00		
Masonry	Brick Painting		\$1,500.00		
Metals	General Flashing		\$800.00		
Rough Carpentry	Interior wall Framing, Gyp and Paint		\$15,000.00		
Finish Carpentry	Trim		\$1,500.00		
Insulation			\$2,000.00		
Doors/Windows	New Exterior Storefront Modification, Doors		\$14,000.00		
Finishes	New LVT Float Flooring Over existing	Interior Paint and Ceiling	\$15,000.00		
Specialties	Toilet Accessories		\$1,200.00		
Mechanical	Reorganize and relocate, Vent in Toilets	Units inside and out are brand new - just need to be relocated attic	\$7,000.00		
Plumbing	Install (5) new fixtures, repair waste as needed	New Water Heater in Attic, extend new water lines	\$12,000.00		
Electrical	New Outlets, Lights, Power, Computer Stations		\$7,500.00		
Sub-Total			\$103,000.00		
General Conditions					
	General,Taxes,Over head, Profit		\$12,000.00		
Total Estimated Cost			\$115,000.00		